



FRONT ELEVATION SCALE: 1/4" = 1'-0"

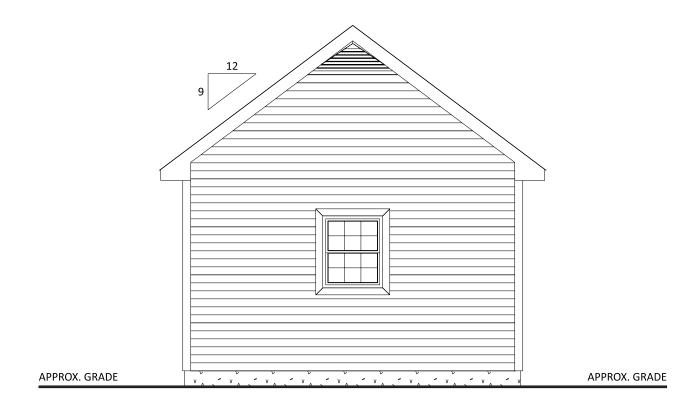

RIGHT ELEVATION SCALE: 1/4" = 1'-0"



REAR ELEVATION SCALE: 1/4" = 1'-0"

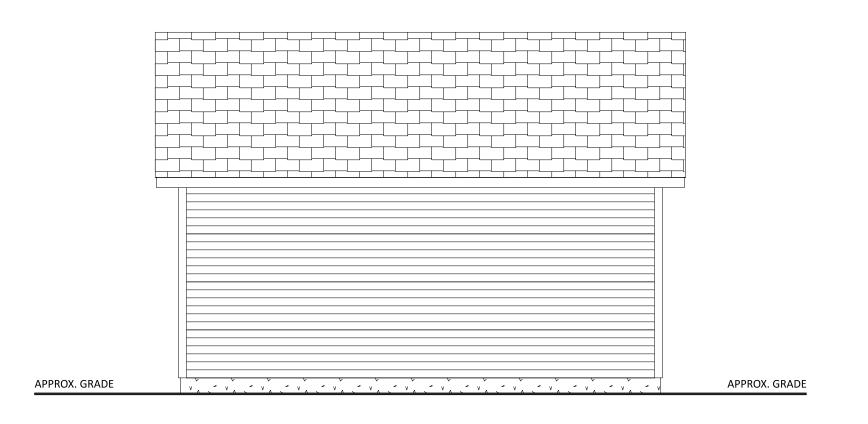

LEFT ELEVATION

SCALE: 1/4" = 1'-0"

FASTENER SCHEDULE FOR STRUCTURAL MEMBERS

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ALTERNATE ATTACHMENTS

NOM. MATERIAL	DESCRIPTION OF FASTENER AND LENGTH	SPA	SPACING OF FASTENERS		
THICKNESS (INCHES)	(INCHES)	EDGES (INCHES)	INTERMEDIATE SUPPORTS (INCHES)		
WOOD STRUCTURAL PANELS, SUBFLOO	R, ROOF AND INTERIOR WALL SHEATHING TO FRAMING AND PARTICLEBOAR	D WALL SHEATHING TO FRAMING			
UP TO 2"	STAPLES 15 GA. 1 3/4 "	4	8		
	NAIL 2 4"	3	6		
	STAPLES 16 GA. 1 3/4 "	3	6		
	STAPLES 14 GA. 2	4	8		
$\frac{23}{32}$ " AND $\frac{3}{4}$ "	STAPLES 15 GA. 1 $\frac{3}{4}$ "	3	6		
	NAIL 2 4"	4	8		

TABLE R602.3(3) REQUIREMENTS FOR WOOD STRUCTURAL PANEL WALL SHEATHING USED TO RESIST WIND PRESSURES

MINIMUM NAIL			MINIMUM NOMINAL	MAXIMUM	PANEL NAIL SPACING		MAXIMUM WIND SPEED (MPH)		
SIZE	PENETRATION (INCHES)	STRUCTURAL PANEL SPAN RATING	PANEL THICKNESS (inches)	WALL STUD SPACING (inches)	I EDGES	FIELD (INCHES O.C.)	WIND EXPOSURE CATEGORY		
							В	С	D
6d COMMON (2.0" X 0.113")	1.5	24/0	3/8	16	6	12	110	90	85
8d COMMON (2.5" X 0.131")	1.75 24,	24/16	7/16	16	6	12	130	110	105
		24/16		24	6	12	110	90	85

GENERAL NOTES

- ALL CONSTRUCTION SHALL COMPLY WITH 2021 INTERNATIONAL RESIDENTIAL CODE NEW JERSEY EDITION.
- BUILDER MUST VERIFY ALL DIMENSIONS AND ACCURACY BEFORE CONSTRUCTION.
- WRITTEN DIMENSIONS SHALL TAKE PRECEDENCE OVER SCALED MEASUREMENTS. - ALL STRUCTURAL LUMBER SHALL BE SPRUCE-PINE-FIR #2 OR BETTER,
- UNLESS OTHERWISE NOTED.
- IF APPLICABLE, WHERE GARAGE IS ATTACHED TO DWELLING UNIT, A (1) HOUR FIRE SEPARATION SHALL BE PROVIDED. (1 LAYER 1/2" DRYWALL)

DOORS BETWEEN AREAS TO BE 20 MIN. C-LABEL DOOR WITH FIRE-CODE JAMB.

- ANY WOOD IN CONTACT WITH MASONRY TO BE PRESSURE-TREATED WOOD.
- GRADE MUST SLOPE AWAY FROM STRUCTURE.
- WOOD FRAMING TO BE MIN. 8" FROM GRADE LEVEL, EXCEPT AT DOORWAYS. - WOOD TRUSSES SHALL BE DESIGNED BY A REGISTERED ENGINEER, BUILDER
- MUST PROVIDE CUT-SHEETS TO CODE OFFICIAL PRIOR TO INSTALLATION.
- WALL BRACING PROVIDED BY CONTINUOUS SHEATHING METHODS
- AS PER SECTION 602.10.
- TEMPERED GLAZING REQUIREMENTS:
- (1) IN WINDOWS & DOORS WITHIN (18) INCHES OF WALKING SURFACE
- (2) IN ANY INDIVIDUAL PANEL GREATER THAN (9) SQ. FT. (3) - IN WINDOWS WITHIN (24) INCHES OF ANY OPENABLE DOOR WHEN DOOR IS IN CLOSED POSITION

(IF SOIL DIFFERS FROM ASSUMED ABOVE REFER TO IRC CODES)

-BUILDING AREA = 280 S.F. -BUILDING VOLUME = 2,380 C.F.

3, 333 3		NE
CODE & LOADING INFORMATION	CONTACT INFORMATION	
- OCCUPANCY TYPE = RESIDENTIAL STORAGE - CONSTRUCTION TYPE = 5 B - 1ST FLOOR SLAB ON GRADE - SNOW LIVE = 30 PSF - DEAD LOADS = 10 PSF - BASIC WIND SPEED = 115 MPH - EXPOSURE CLASS C - FROST LINE DEPTH = 36" - SEISMIC DESIGN CATEGORY = B - ASSUMED SOIL CLASS = GM, GC - SOIL BEARING CAPACITY = 2000 PSF	OWNER: Elvin Delarosa 107 Park Place North Plainfield, NJ 07060 Phone: 862-220-5219	SHEET TO CO

Е

 ${\bf Designing \text{-} Drafting \text{-} 3D \ Color \ Renderings}$

5219 Old Strasburg Rd. Kinzers, PA 17535 P. 717-442-5053 F. 717-370-5925

ANY CHANGES FROM THESE DRAWINGS MUST BE BROUGHT TO THE ATTENTION OF DRAFTING CONCEPTS AND APPROVED BEFORE CONSTRUCTION. ALL DIMENSIONS AND SITE CONDITIONS SHALL BE VERIFIED BY CONTRACTOR PRIOR TO CONSTRUCTION. THESE DRAWINGS SHALL NOT BE USED FOR ANY OTHER PROJECTS.

JAMES A. KOPPENHAVER

575 VAN REED RD, WYOMISSING, PA 19610

PHONE: 484-794-9949

TE	ITEM	ВҮ
/23	FINAL	E.S.
/24	REVISED FINAL	E.S.


PROJECT TITLE:

EW GARAGE


TITLE: Cover sheet RECEIVED: 8/29/23

> AS NOTED VING NO:


D754-23

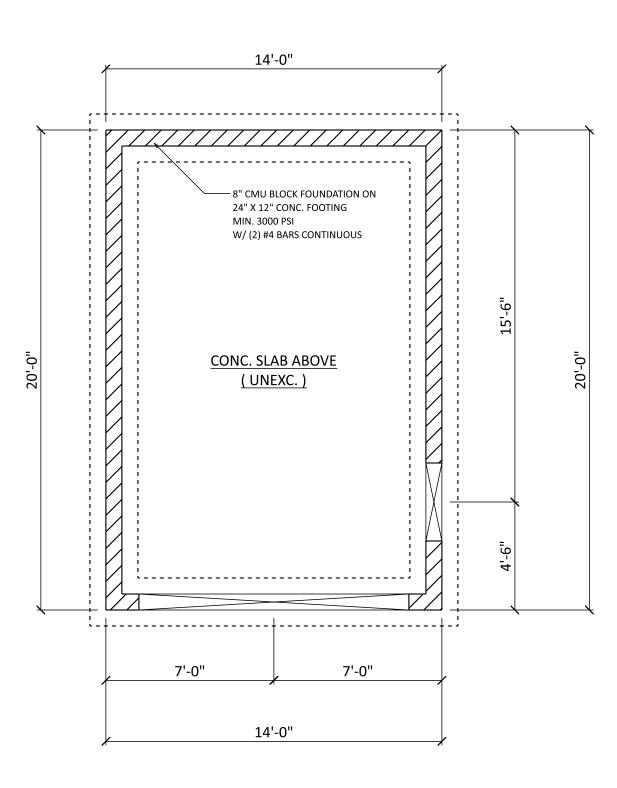


FOUNDATION PLAN
SCALE: 1/4" = 1'-0"

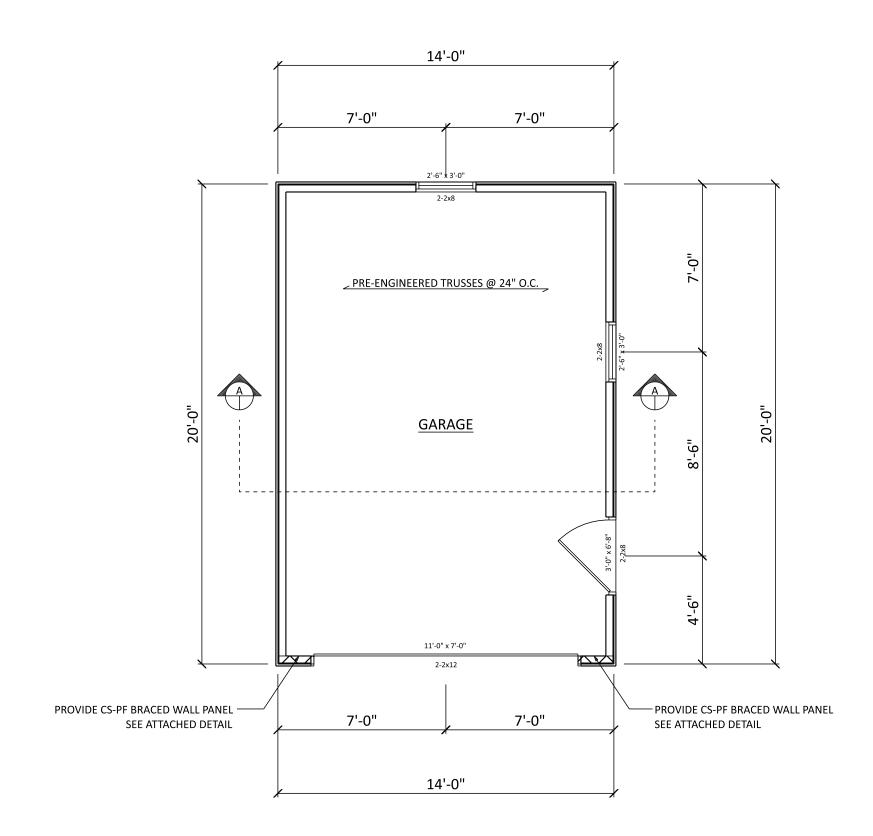

FLOOR PLAN
SCALE: 1/4" = 1'-0"

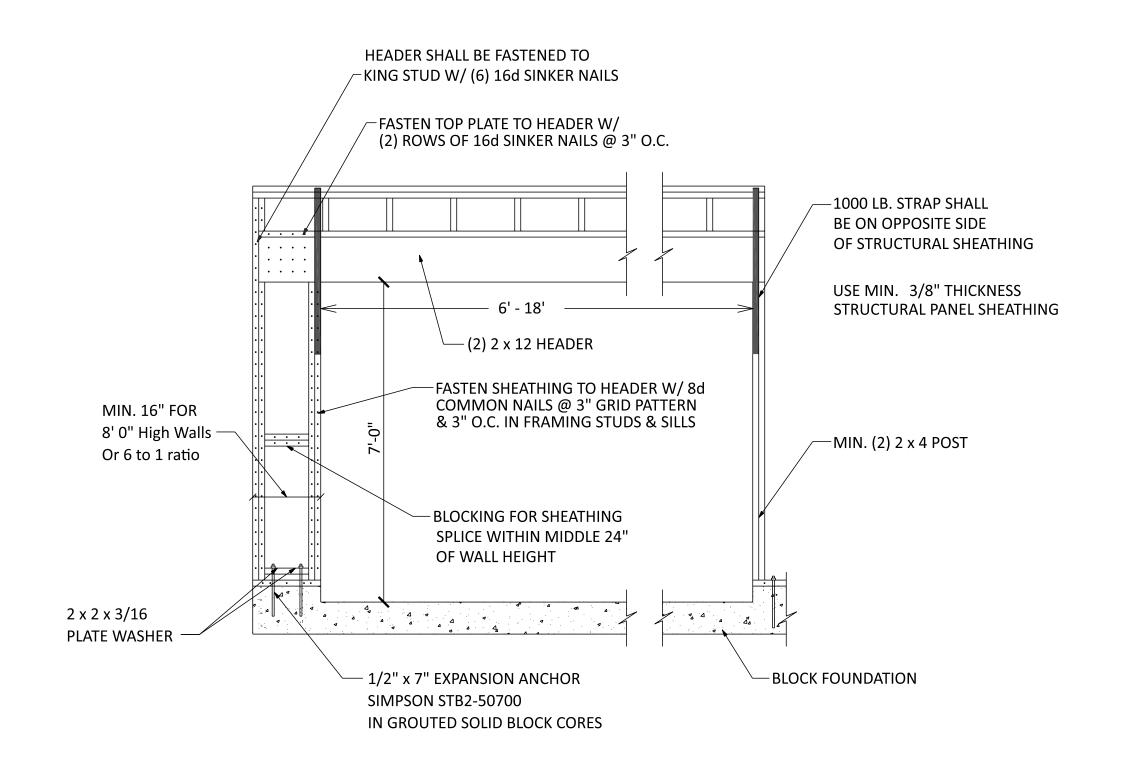

CS-PF PORTAL FRAME BRACED WALL DETAIL

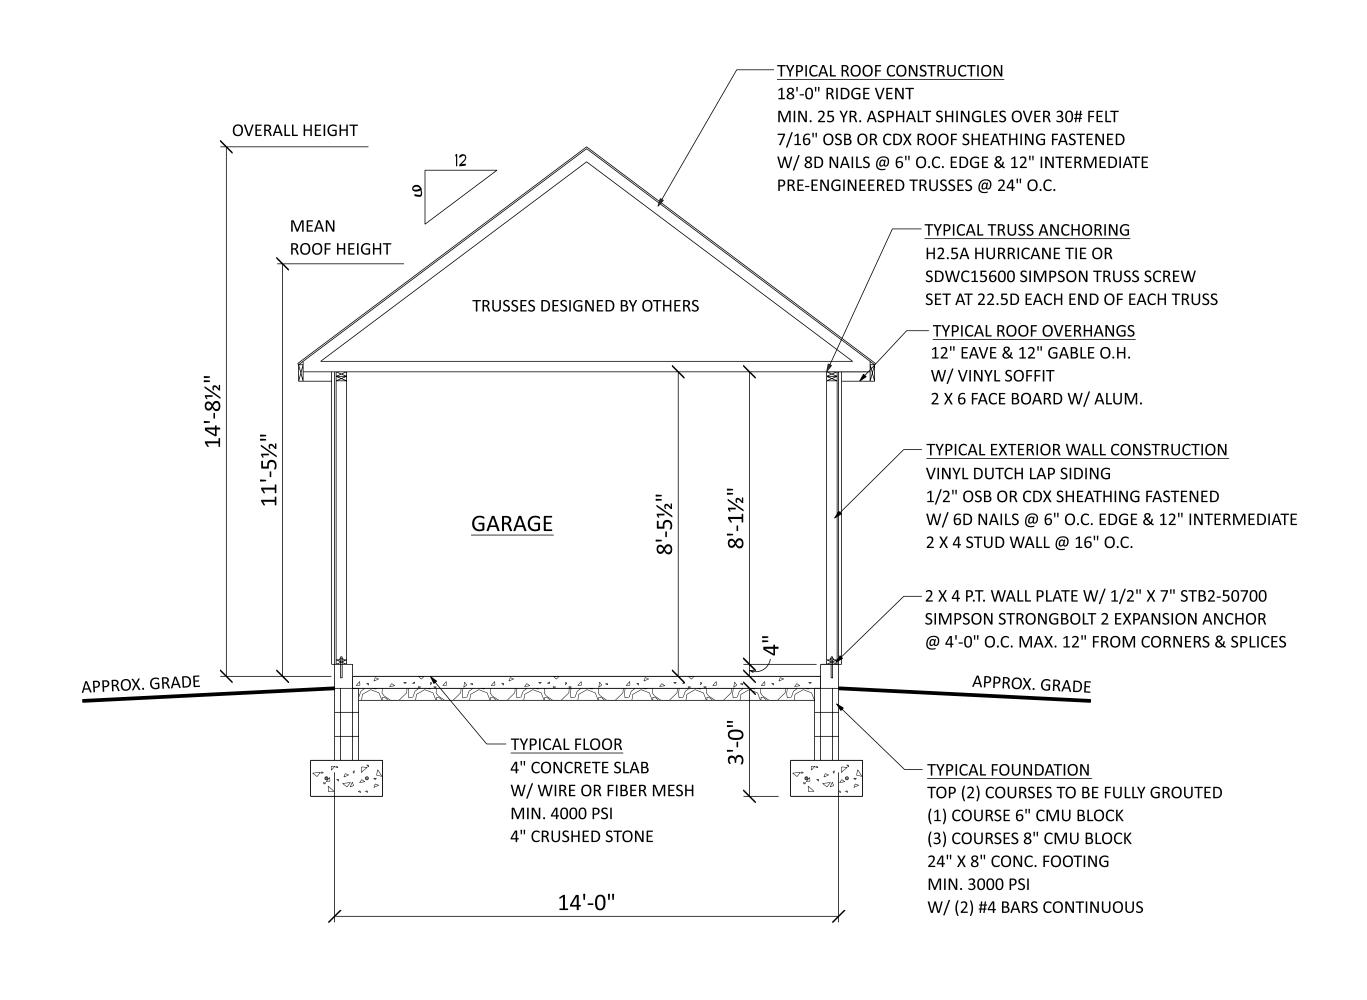

SECTION A
SCALE: 3/8" = 1'-0"



P. 717-442-5053 F. 717-370-5925

ANY CHANGES FROM THESE DRAWINGS
MUST BE BROUGHT TO THE ATTENTION

MUST BE BROUGHT TO THE ATTENTION
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PHONE: 484-794-9949

Έ	ITEM	ВҮ	
/23	FINAL	E.S.	
24	REVISED FINAL	E.S.	

CONTRACTOR:
Amish Built, Inc 1390 Columbia Ave Lancaster, PA 17603 717-431-8611

orth Plainfield, NJ 07060

ECT SITE:

PROJECT TITLE:

NEW GARAGE

SHEET TITLE:
Floor plan
DATE RECEIVED:

SCALE:

8/29/23

AS NOTED DRAWING NO:

D754-23

2

- Carriage style garage door
- · Wood sash windows 4 or 6 panes
- · Architectural asphalt shingles that match the the existing roof
- · Cedar wood shingle siding painted to match the house
- 9 pane glass exterior door



- Carriage style garage door
- · Wood sash windows 4 or 6 panes
- · Architectural asphalt shingles that match the house
- Vinyl dutch lap siding that matches garage sides and vinyl cedar look staggered shingle for the front of garage to match the house.

